




**North East Elevation**  
SCALE 1:250

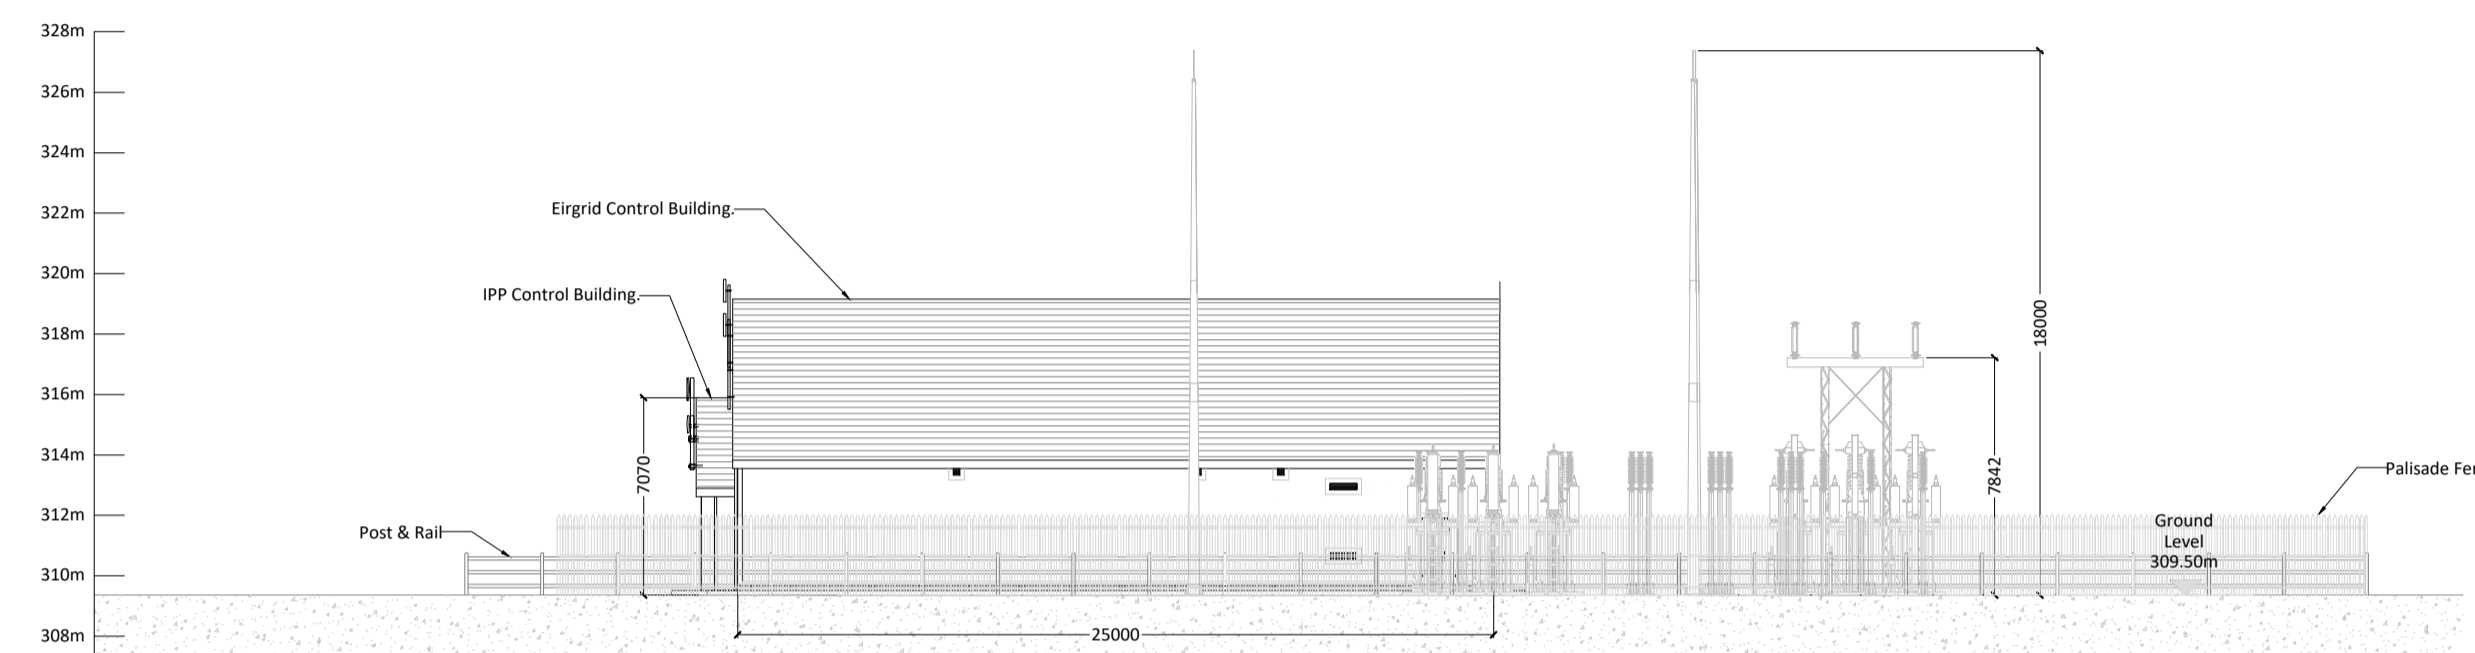

**South West Elevation**  
SCALE 1:250

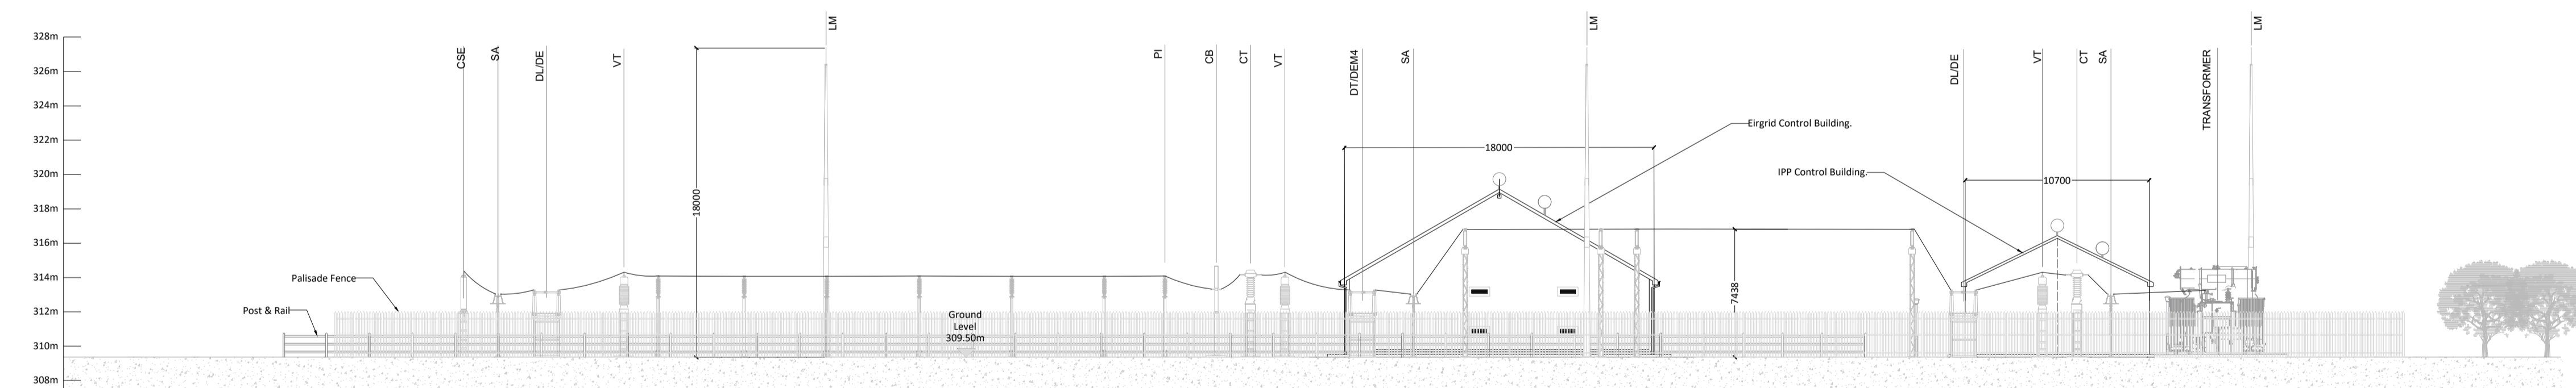

**South East Elevation**  
SCALE 1:250

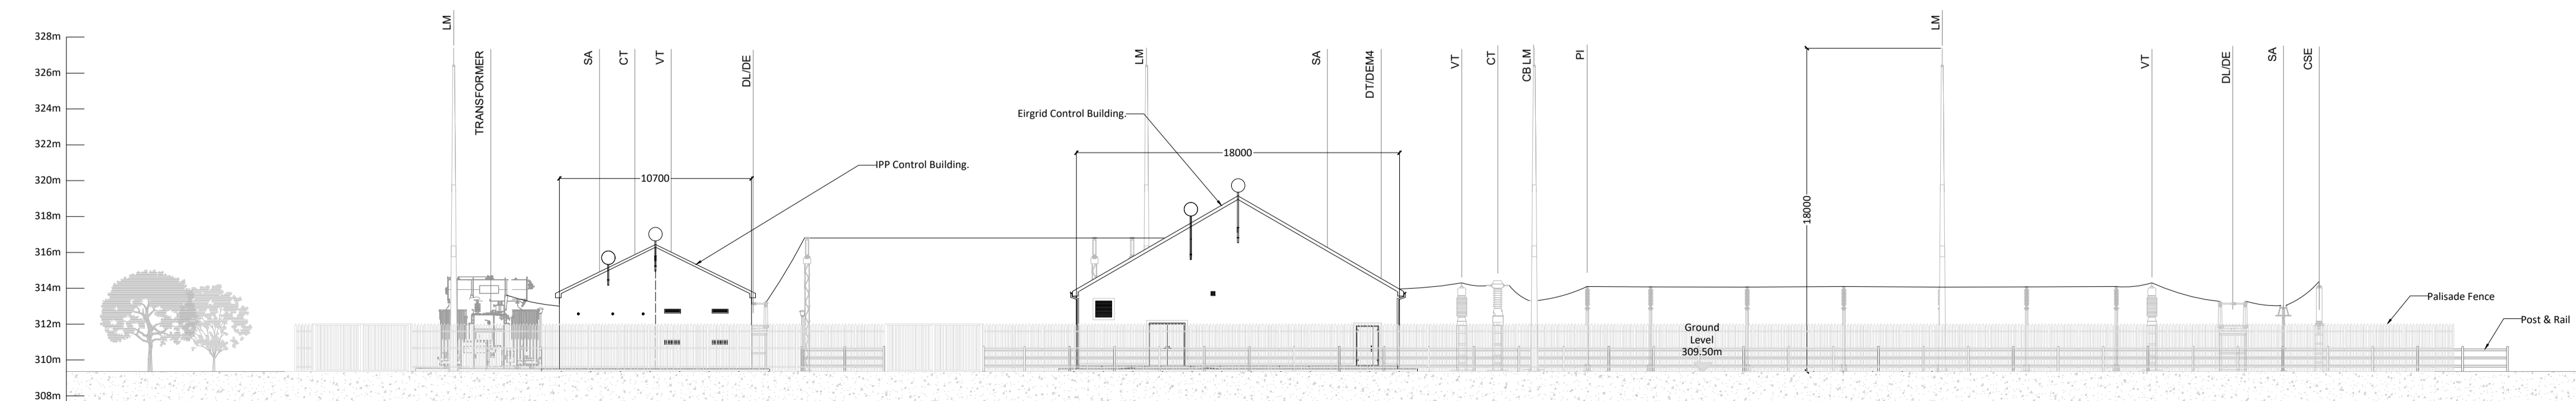

**North West Elevation**  
SCALE 1:250

- NOTES: -
1. Layout and Arrangements of Substation Building and Electrical Equipment is shown indicatively and for illustration purposes only.
  2. Dimensions shown are as per current EirGrid Specifications at the time of submission. Dimensions may vary at time of construction to reflect any revisions to EirGrid Specifications.
  3. Final Specifications of Buildings and Electrical Equipment is to be as per EirGrid and ESB Specifications.
  4. The Elevation of the Compound is indicative and will be finalised to project design to ensure Cut/Full Earthworks associated with the construction of the Compound are balanced.
  5. Heights shown are Levels (m) relative to Datum Malin Head

LEGEND: -

	Description
CSE	Cable Sealing End.
SA	Surge Arrester.
DL/DE	Line / Earth Disconnect.
VT	Voltage Transformer.
CT	Current Transformer.
CB	Circuit Breaker.
PI	Post Insulator.
LM	Lightning Mast.

ISSUE/REVISION

I/R	DATE	DESCRIPTION
P4	02.10.2023	Issued For Planning
P3	23.08.2023	Issued For Planning
P2	26.07.2023	Issued For Planning
P1	13.01.2023	Issued For Planning

PROJECT NUMBER

05-828

SHEET TITLE

Proposed Station Elevations

SHEET NUMBER

05828-DR-180